

## A. Description of Activity

Please describe the proposed activity in detail – where the site is located, please use NZTM GPS coordinates where possible, what you intend to use the building for, whether you intend to make any changes to the infrastructure.

Please include the name and status of the public conservation land, the size of the area for which you are applying and why this area has been chosen.

If necessary, attach further information including a map, a detailed site plan and drawings of proposal and label Attachment 3b:A.

Construct + maintain toilet block for public use.

## B. Alternative sites considered

If your application is to **build, extend or add** to any permanent or temporary structures or facilities on public conservation land, please provide the following details:

- Could this structure or facility be reasonably located outside public conservation land? Provide details of other sites/areas considered.
- Could any potential adverse effects be significantly less (and/or different) in another conservation area or another part of the conservation area to which the application relates? Give details/reasons

Bruce Park Scenic Reserve promoted as a 'short-stop' destination for travellers on SH1. Site chosen is old road; selected for ease of access + minimal impact.

## C. Larger area

Is the size of the area you are applying for **larger** than the structure/facility

YES / NO

If yes, please detail the size difference in the box below, and answer the following 3 questions, if no please go on to the next section:

Is this necessary for safety or security purposes?

YES / NO

Is this necessary as an integral part of the activity?

YES / NO

Is this essential to carrying on the activity?

YES / NO

If the answer to any of the above is yes, please provide details and attach supporting evidence if necessary and label Attachment 3b:C.

## D. Exclusive possession

Do you believe you need **exclusive possession** of the public conservation land on which your structure/building is located, ie no one else can use the land during your use of it? *(Exclusive occupation requires a lease which requires public notification of the application)*

YES  NO

If yes, please answer the following 3 questions, if no please go to the next section:

Is exclusive possession necessary to protect public safety?

YES / NO

Is exclusive possession necessary to protect physical security of the activity?

YES / NO

Is exclusive possession necessary for the competent operation of the activity?

YES / NO

If the answer to any of the above is yes, please provide details and attach supporting evidence if necessary and label Attachment 3b:D.

## E. Technical Specifications (for telecommunications sites only)

Frequencies on which the equipment is to operate

Power to be used (transmitter output)

Polarisation of the signal

Type of antennae

The likely portion of a 24 hour period that transmitting will occur

Heaviest period of use

## F. Term

Please detail the length of the term sought (i.e. number of years or months) and why.

*Note: An application for a concession for a period over 10 years must be publicly notified, an application for a concession up to 10 years will not be publicly notified unless the adverse effects of the activity are such that it is required, or if an exclusive interest in the land is required.*

33 years

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## G. Bulk fuel storage

Under the Hazardous Substances and New Organisms Act 1996 (HSNO Act) 'Bulk fuel storage' is considered to be any single container, stationary or mobile, used or unused, that has a capacity in excess of 250 litres of Class 3 fuel types. This includes petrol, diesel, aviation gasoline, kerosene and Jet A1. For more information on Hazardous Substances, go to:  
<http://www.business.govt.nz/worksafe/information-guidance/legal-framework/hsno-act-1996>

Do you intend to store fuel in bulk on the land as part of the activity?

YES  NO

If you have answered yes, then please provide full details of how and where you intend to store the fuel, and label any attachments including plans, maps and/or photographs as Attachment 3b:G. If your concession application is approved you will be required to provide a copy of your HSNO compliance certification to the Department before you begin the activity.

## **H. Environmental Impact Assessment**


This section is one of the most important factors that will determine the Department's decision on the application. Please answer in detail.

In column 1 please list all the locations of your proposal, please use NZTM GPS coordinates where possible. In column 2 list any special features of the environment or the recreation values of that area. Then in column 3 list any effects (positive or adverse) that your activity may have on the values or features in column 2. In column 4 list the ways you intend to mitigate, remedy or avoid any adverse effects noted in column 3. Please add extra information or supporting evidence as necessary and label Attachment 3b:H.

Refer to Steps 1 and 2 in your Guide to Environmental Impact Assessment to help you fill in this section.


<b>Location on public conservation land</b>	<b>Special feature or value</b>	<b>Potential effects of your activity on the feature or value (positive or adverse)</b>	<b>Methods to remedy, mitigate or avoid any adverse effects identified</b>
Bruce Park Scenic Reserve	Podocarp and broadleaf forest remnant with specimens of Rimu, Totara and Kahikatea.	Positive – Reduction of off track toileting.  Adverse – Nil	<ol style="list-style-type: none"><li>1. Vault toilet to be installed to eliminate any ground contamination surrounding the toilet.</li><li>2. The toilet is positioned on a grassed area to avoid any damage to native flora and fauna.</li><li>3. The toilet is sufficient distance from any water source to ensure the site does not become flooded.</li><li>4. The toilet will be serviced regularly to ensure it remains hygienic.</li></ol>

## Bruce Park Toilet Site

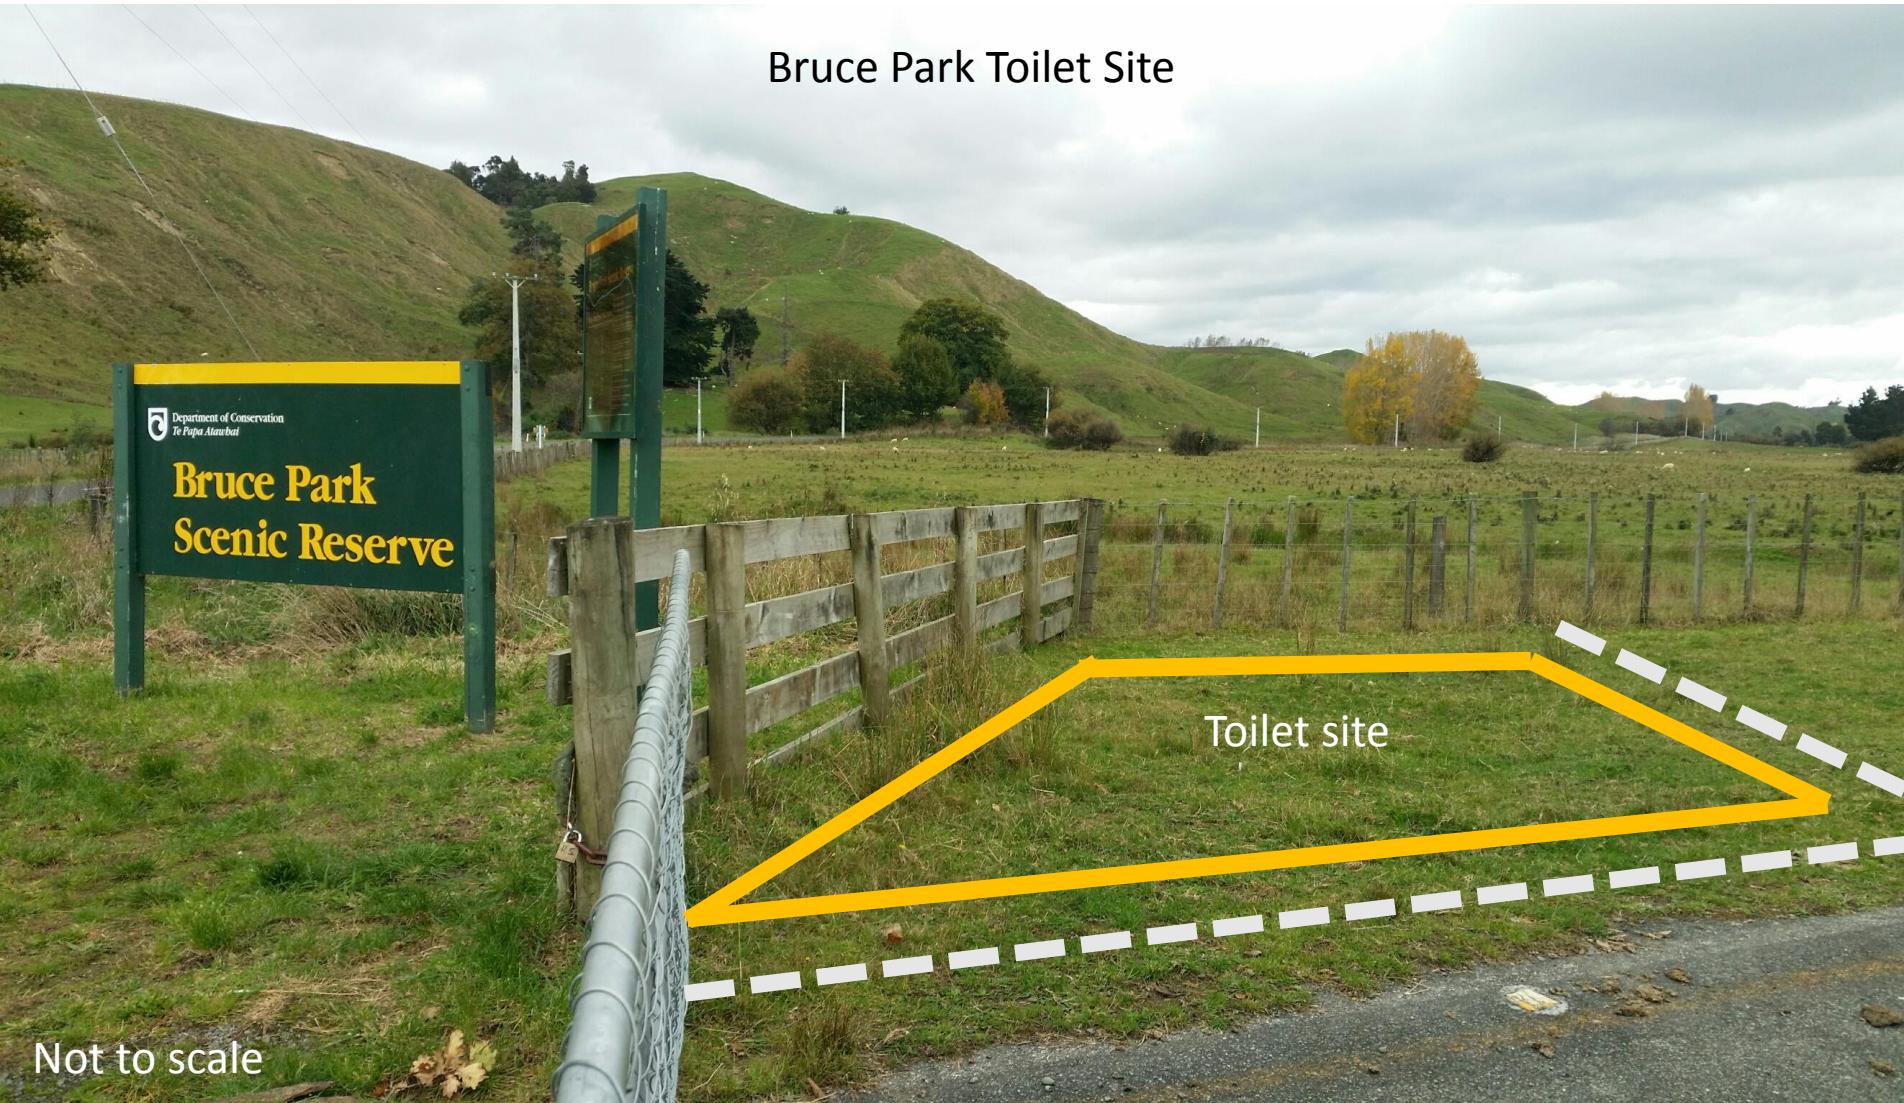


— = Post and rail fence  
— = Concrete pad as per PS1 design

## Bruce Park Toilet Site

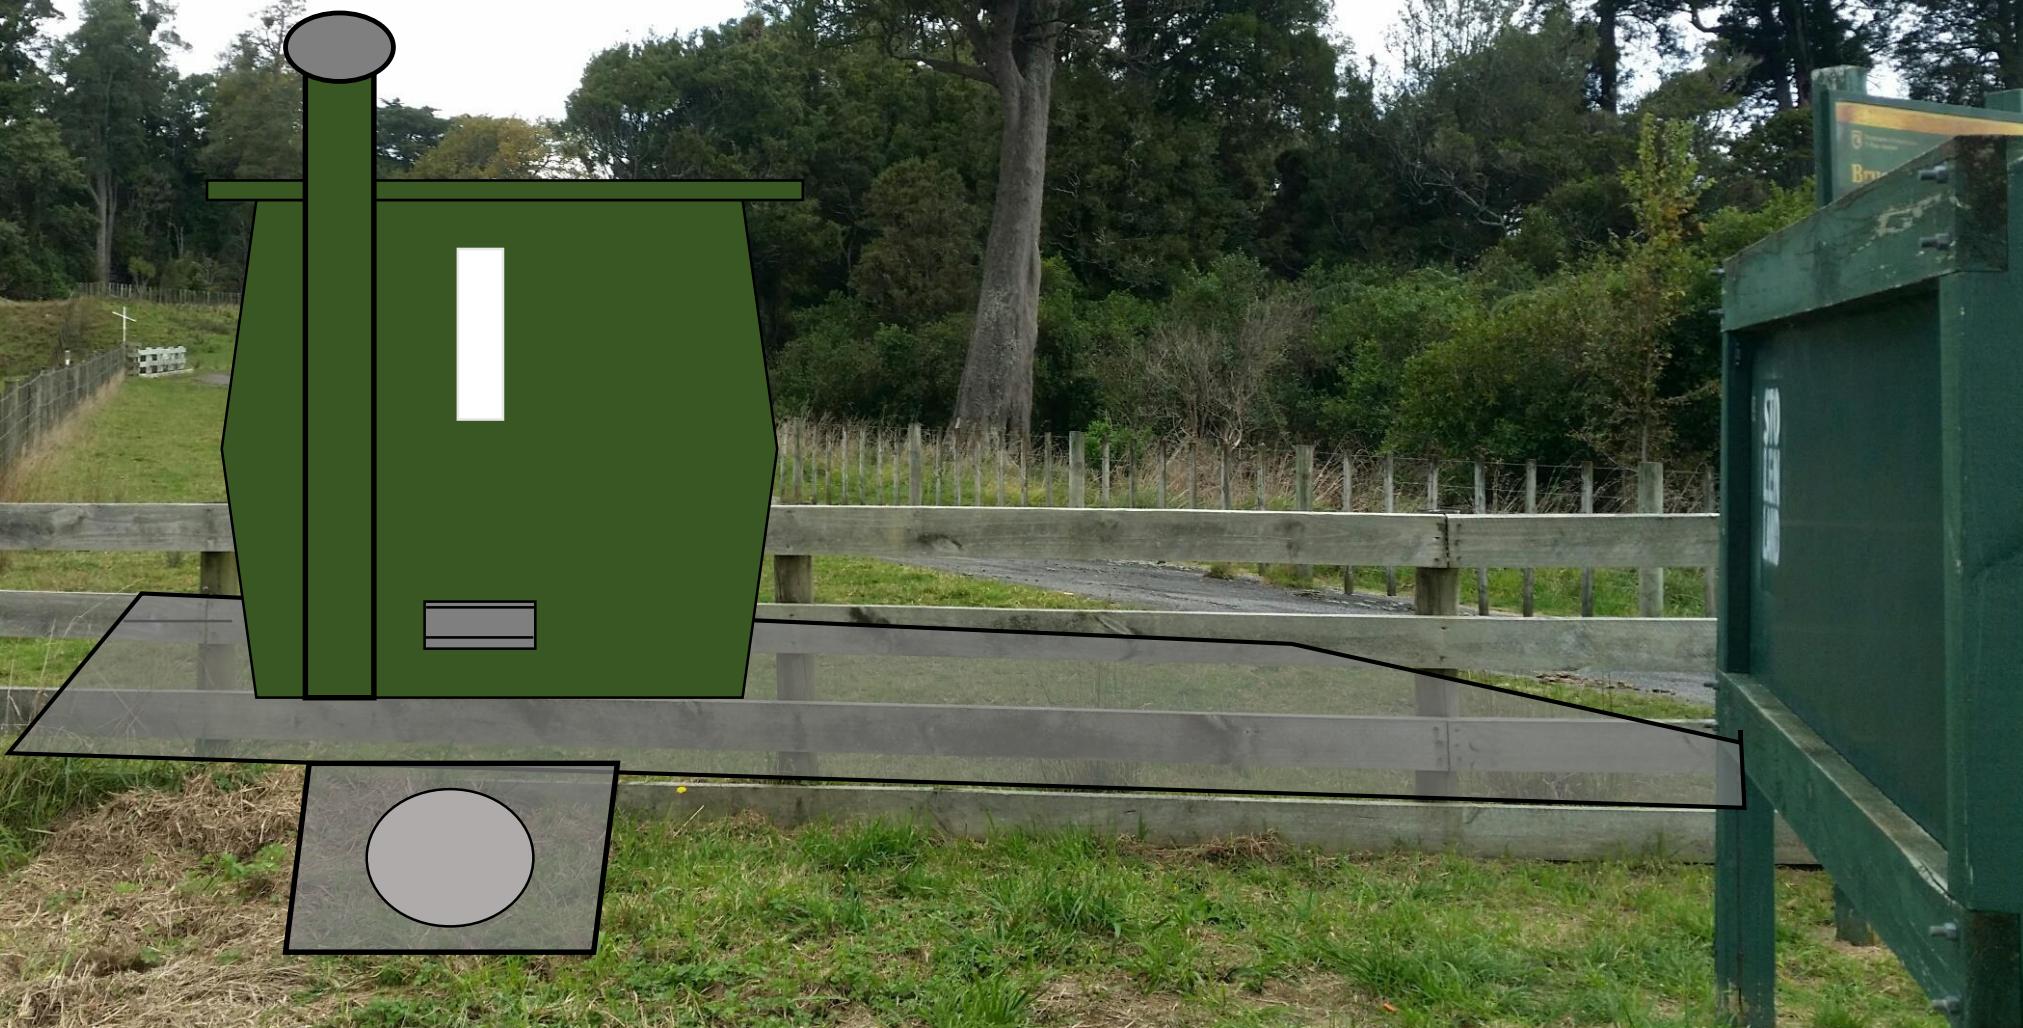

Not to scale

# Site overview

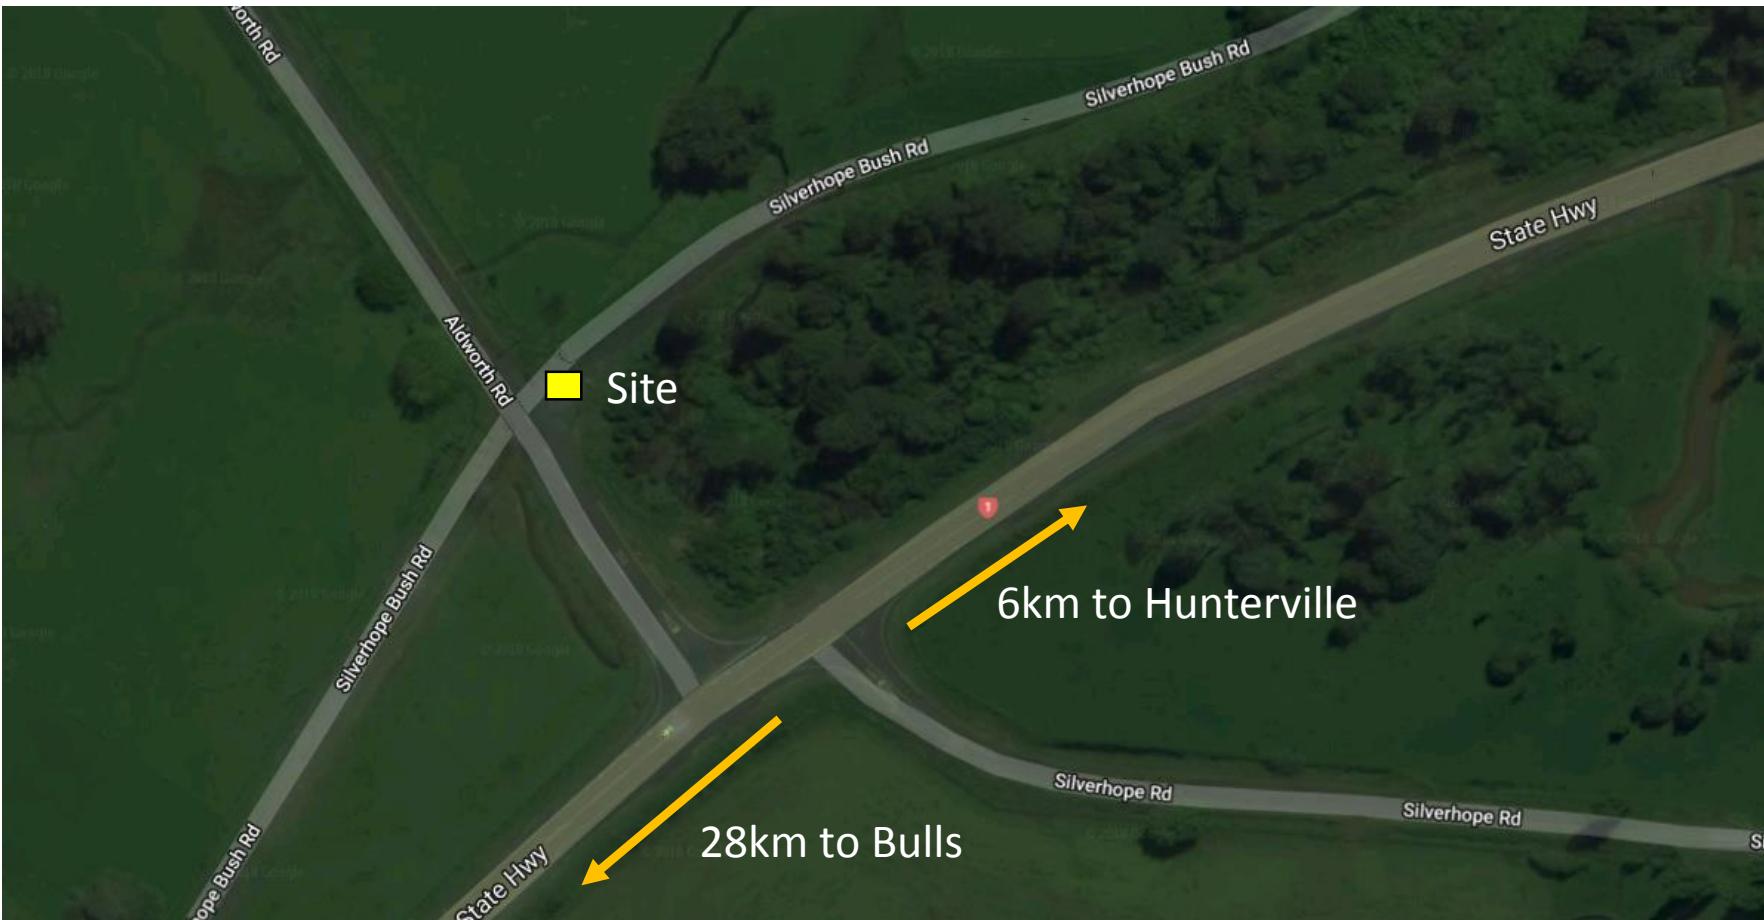

**GENERAL NOTES CONCERNING:  
BUILDING CODE COMPLIANCE FOR PERMACRETE PUBLIC TOILET  
STRUCTURES**

THIS PUBLIC TOILET IS CLASSED AS AN ALCILLARY BUILDING UNDER THE NEW  
ZEALAND BUILDING CODE HANDBOOK CLAUSE A1-CLASSIFIED USES

**7.0 OUTBUILDINGS**  
7.0.1 Applies to a building or use which may be included within each classified use but  
are not intended for human habitation and are accessory to the principal use of  
associated buildings. Examples: a carport, farm building, garage, greenhouse,  
associated room, private swimming pool, public toilet or shed.

**CERTAIN REQUIREMENTS OF THE NZBC DO NOT APPLY TO OUTBUILDINGS  
(PUBLIC TOILETS IN THIS CASE)**

**Functional requirement E2.2**  
Buildings must be constructed to provide adequate resistance to penetration by, and  
the accumulation of, moisture from the outside.

Requirement E2.2 does not apply to buildings (for example, certain bus shelters, and  
certain buildings used for horticulture or for equipment for washing motor vehicles  
automatically) if moisture from the outside penetrating them, or accumulating within  
them, or both, is unlikely to impair significantly all or any of their amenity, durability,  
and stability.

**Performance**

E3.3.1 An adequate combination of thermal resistance, ventilation, and space  
temperature must be provided to all habitable spaces, bathrooms, laundries, and other  
spaces where moisture may be generated or may accumulate.

Performance E3.3.1 does not apply to Commercial Non-residential, Commercial/  
Industrial, Outbuildings, or Ancillary buildings.

**COMMENT:** THE PERMACRETE PUBLIC TOILET UNITS HAVE BEEN DESIGNED  
WITH TILED FLOORS TO BE HOSED OUT REGULARLY FOR CLEANING. THE  
CONCRETE CONSTRUCTION OF THE UNIT WAS CHOSEN FOR ITS DURABILITY &  
STABILITY.

THE UNIT IS CONSTRUCTED & COMPLETELY FIT OUT OFF SITE & LOWERED  
INTO PLACE. THERE IS NO REQUIREMENT OR ADVANTAGE TO THE THE  
INSTALLATION OF A PFM SUB-FLOOR, ROOF OR CEILING LININGS, OR THE  
INSTALLATION OF ROOFING UNDERLAY TO AN OPEN ROOF SPACE.

**PERMACRETE**  
PERMANENT SOLUTIONS  
SINCE 1980

Project: **PERMALOO STANDARD  
DRY VAULT SINGLE  
TOILET UNIT**

Model No.: **PLS DV 1**

Issued for: **Date:**  
Structural review 12 Jan 2015


Client information: **Date:**  
Building consent 13 Jan 2015


Drawing: **Typical Floor Plan**

Revision: **Scale @ A2:**  
Drawing: 1:20


Dwg No. **1-1**

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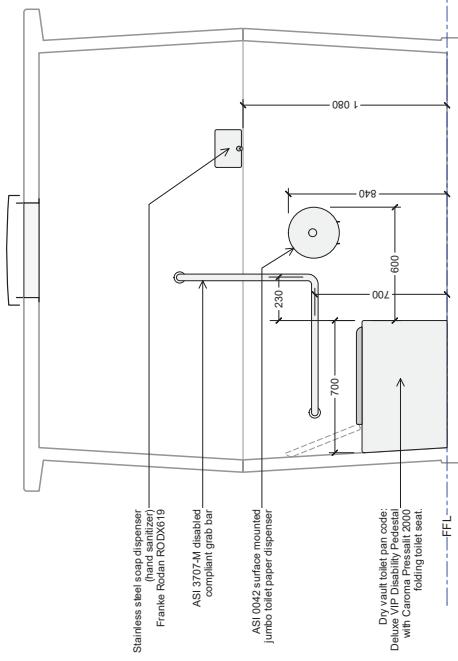


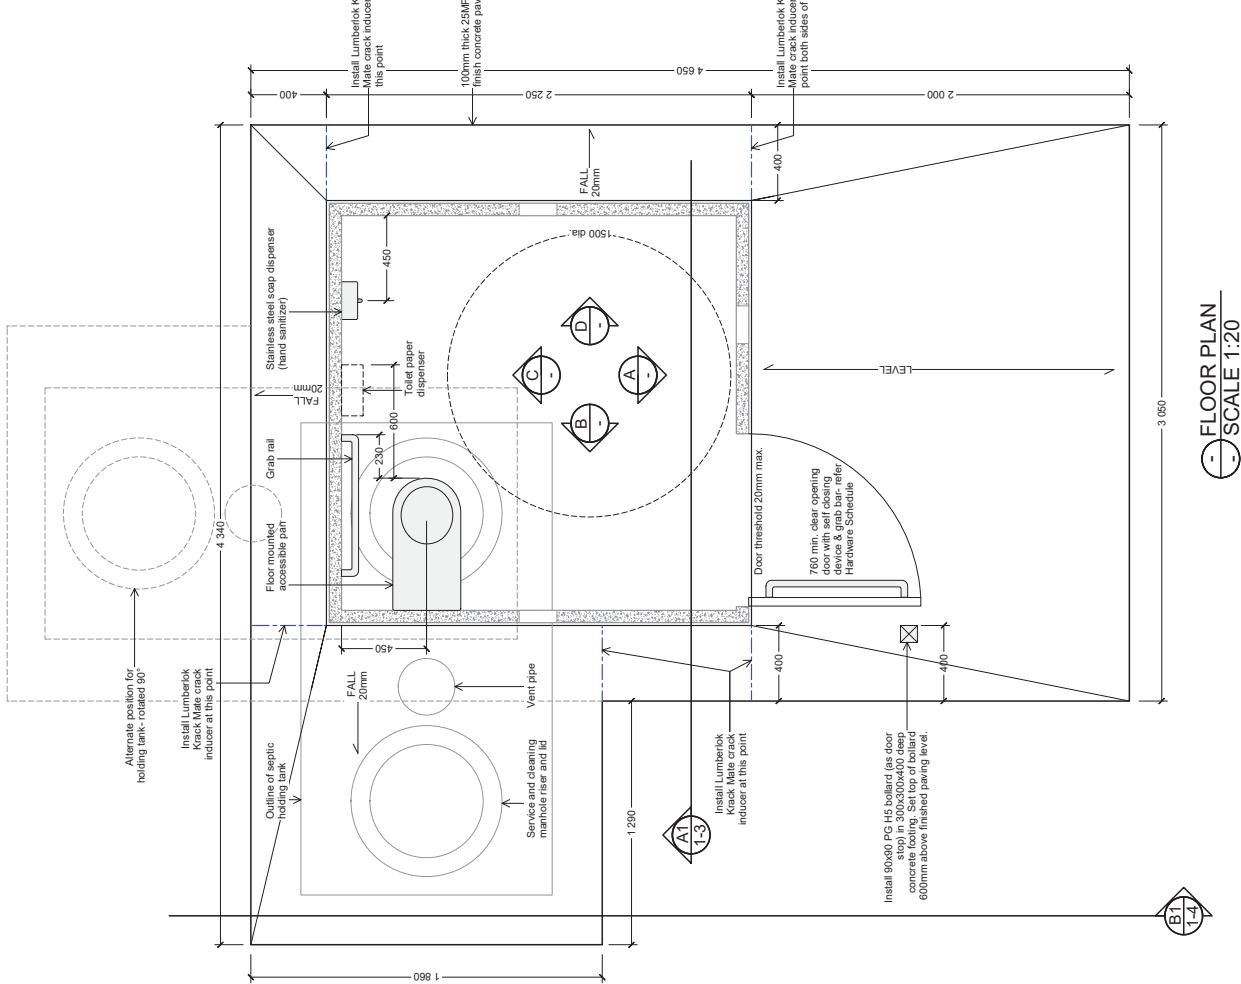

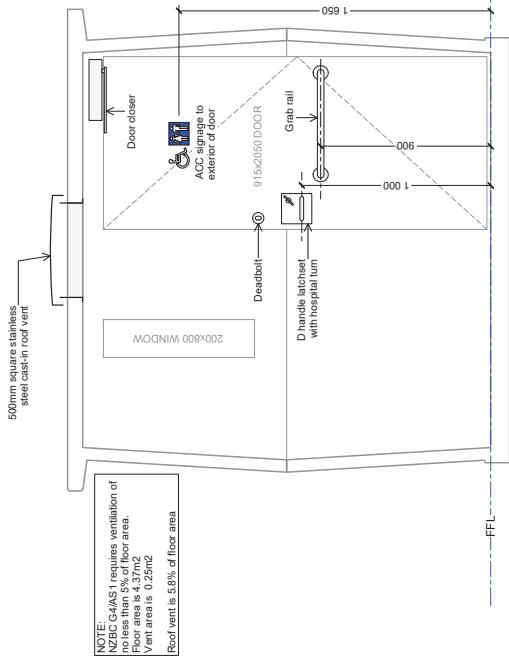
**(A)** INTERNAL ELEVATION A  
1:1 SCALE 1:20

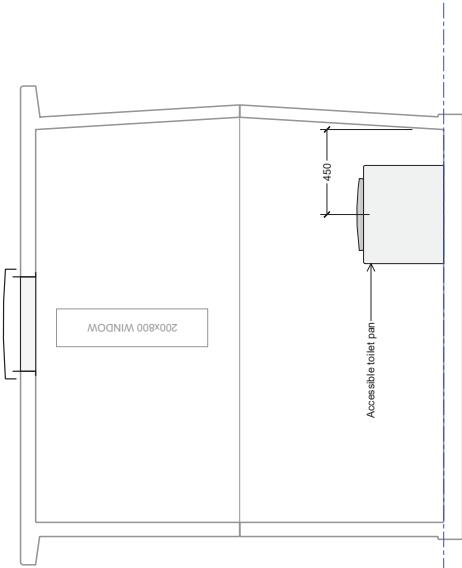

**(B)** INTERNAL ELEVATION B  
1:1 SCALE 1:20



**(C)** INTERNAL ELEVATION C  
1:1 SCALE 1:20

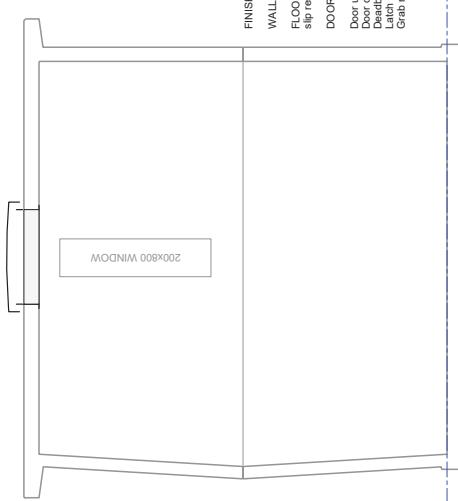


**(D)** INTERNAL ELEVATION D  
1:1 SCALE 1:20

Project:	<b>PERMACRETE</b> PERMANENT SOLUTIONS SINCE 1980		
Issued for:	Structural review	Date:	12 Jan 2015
	Client information		
	Building consent		13 Jan 2015
Drawing: <b>PLS DV 1</b>			
Revision:	Scale @ A2:	1:20	
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**1-2**



**A1 SECTION A1  
1:20 SCALE**



**HOLDING TANK SYSTEM NOTES:**  
THIS IS A PERMALOO PUBLIC TOILET UNIT WITH A HOLDING TANK SYSTEM. THIS IS NOT AN EFFLUENT DISPOSAL SYSTEM. IT MUST BE EMPTIED REGULARLY BY COUNCIL CONTRACTORS. IT REQUIRES REGULAR ON SITE CHECKING TO UNDERSTAND HOW MUCH USE IT RECEIVES THROUGHOUT THE SEASONS TO DEVELOP A MAINTENANCE PLAN FOR EMPTYING.  
GENERALLY THE COUNCIL MAIN TENANCE CONTRACTOR WILL TAKE CARE OF THE SAME. THE SAME AS WELL AS CARRY OUT THEIR SCHEDULED GENERAL CLEANING & MAINTENANCE.

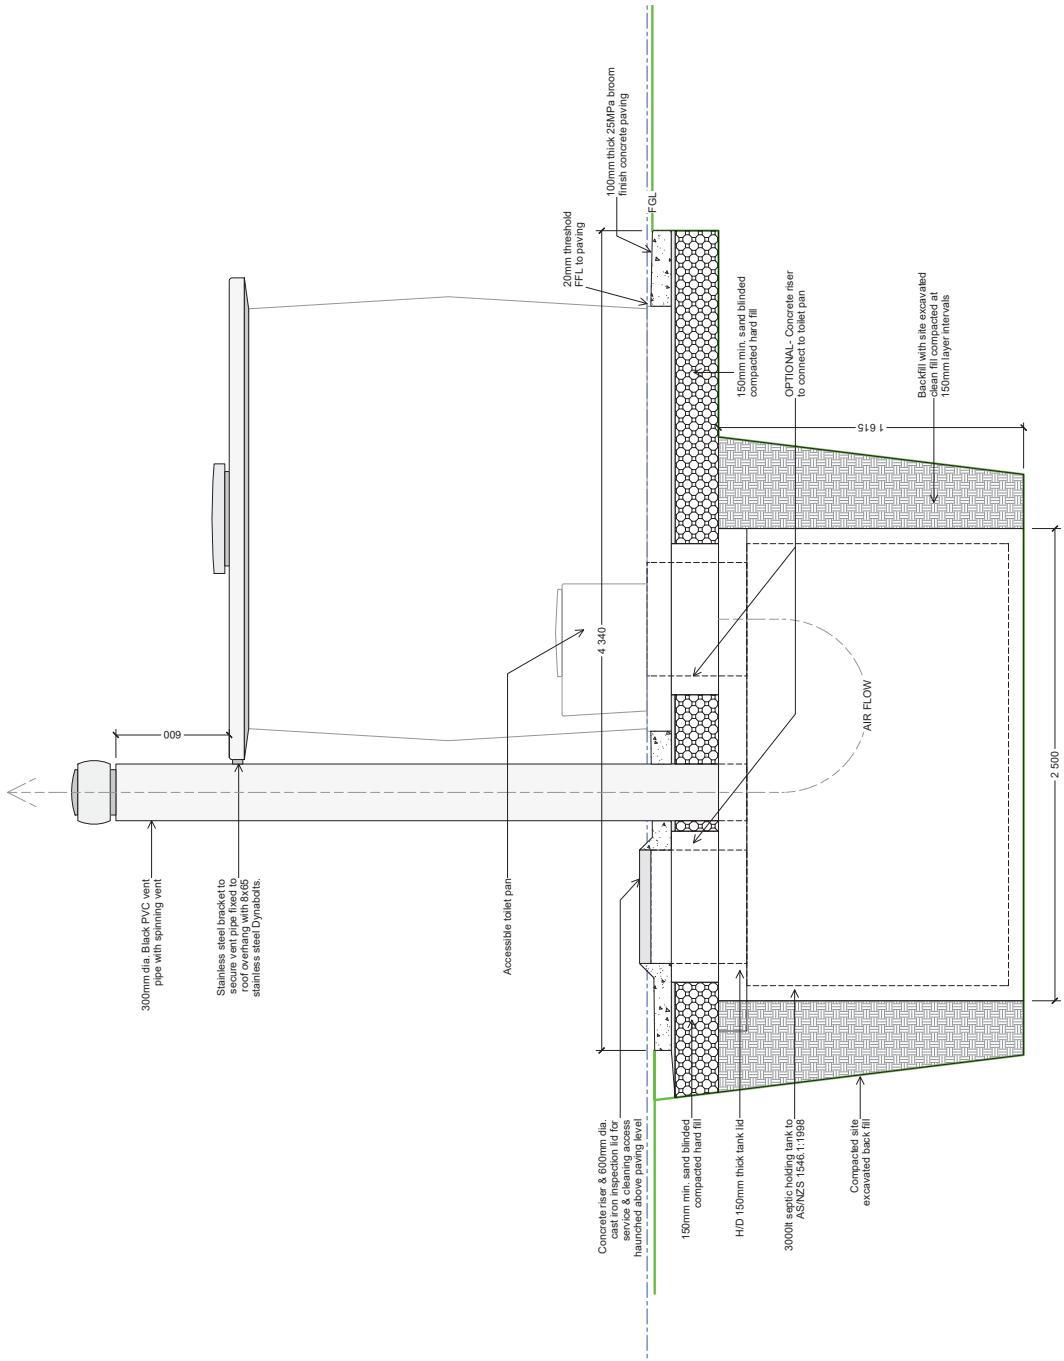**HOLDING TANK  
SECTION A1**  
Drawing:

**PLS DV 1**  
Project:  
**PERMALOO STANDARD DRY VAULT SINGLE TOILET UNIT**  
Model No.:  
**PERMACRETE GIBSONE**  
Drawing:  
**HOLDING TANK SECTION A1**  
Date:  
Structural review 12 Jan 2015  
Client information  
Building consent 13 Jan 2015  
Revision: Scale @ A2: 1:20  
Dwg No.

**1-3**

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**FOR CONSENT**

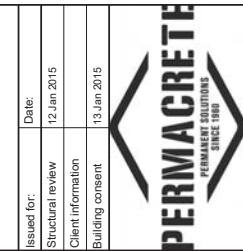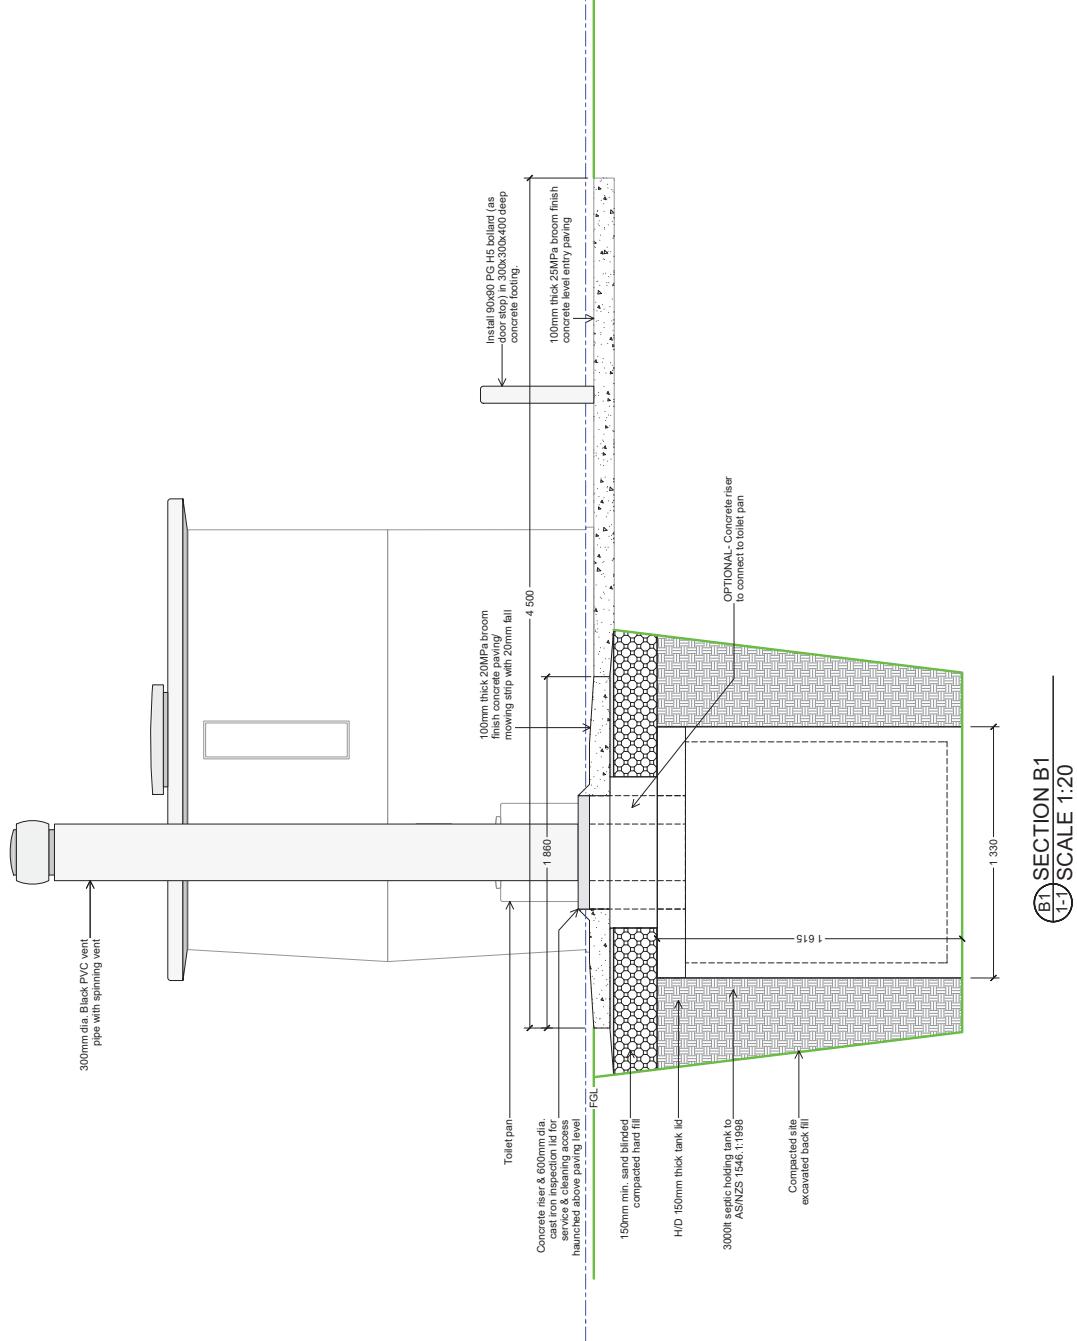Project:  
**PERMALOO STANDARD DRY VAULT SINGLE TOILET UNIT**  
Model No.:  
**PLS DV 1**

Issued for:  
Structural review 12 Jan 2015  
Client information  
Building consent 13 Jan 2015  
Drawing:  
**HOLDER TANK SECTION B1**  
Revision: Scale @ A2: 1:20  
Dwg No.

**1-4**

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**PERMALOO STANDARD  
DRY VAULT SINGLE  
TOILET UNIT**

**PERMACRETE GIBSONE**  
Model No.: **PLS DV 1**

Drawing: UNIT CONSTRUCTION & REINFORCEMENT

<b>DETAILS</b>	
Revision:	Scale @ A2:
	1:20 Dwg. No.:

1-5

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